


PICTURE "C"

N.T.S

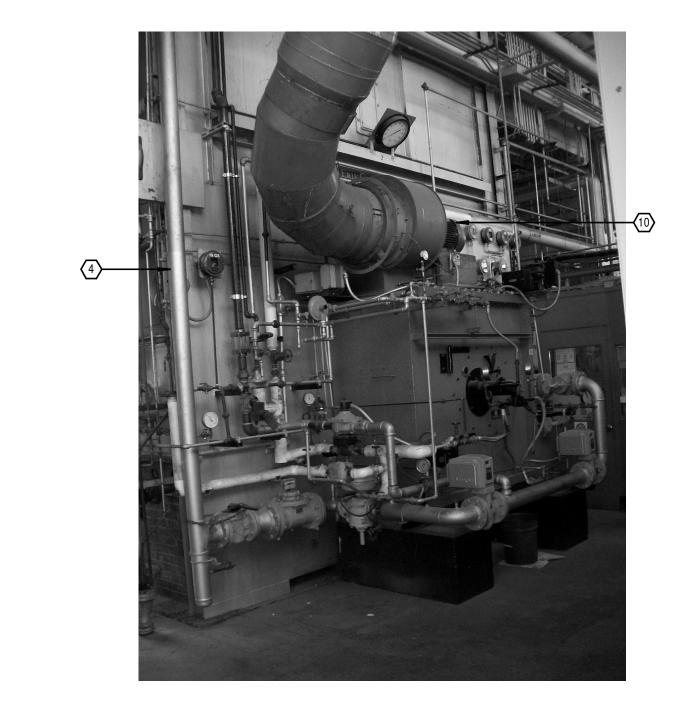


5 PICTURE "D"

N.T.S

CONSULTANTS:



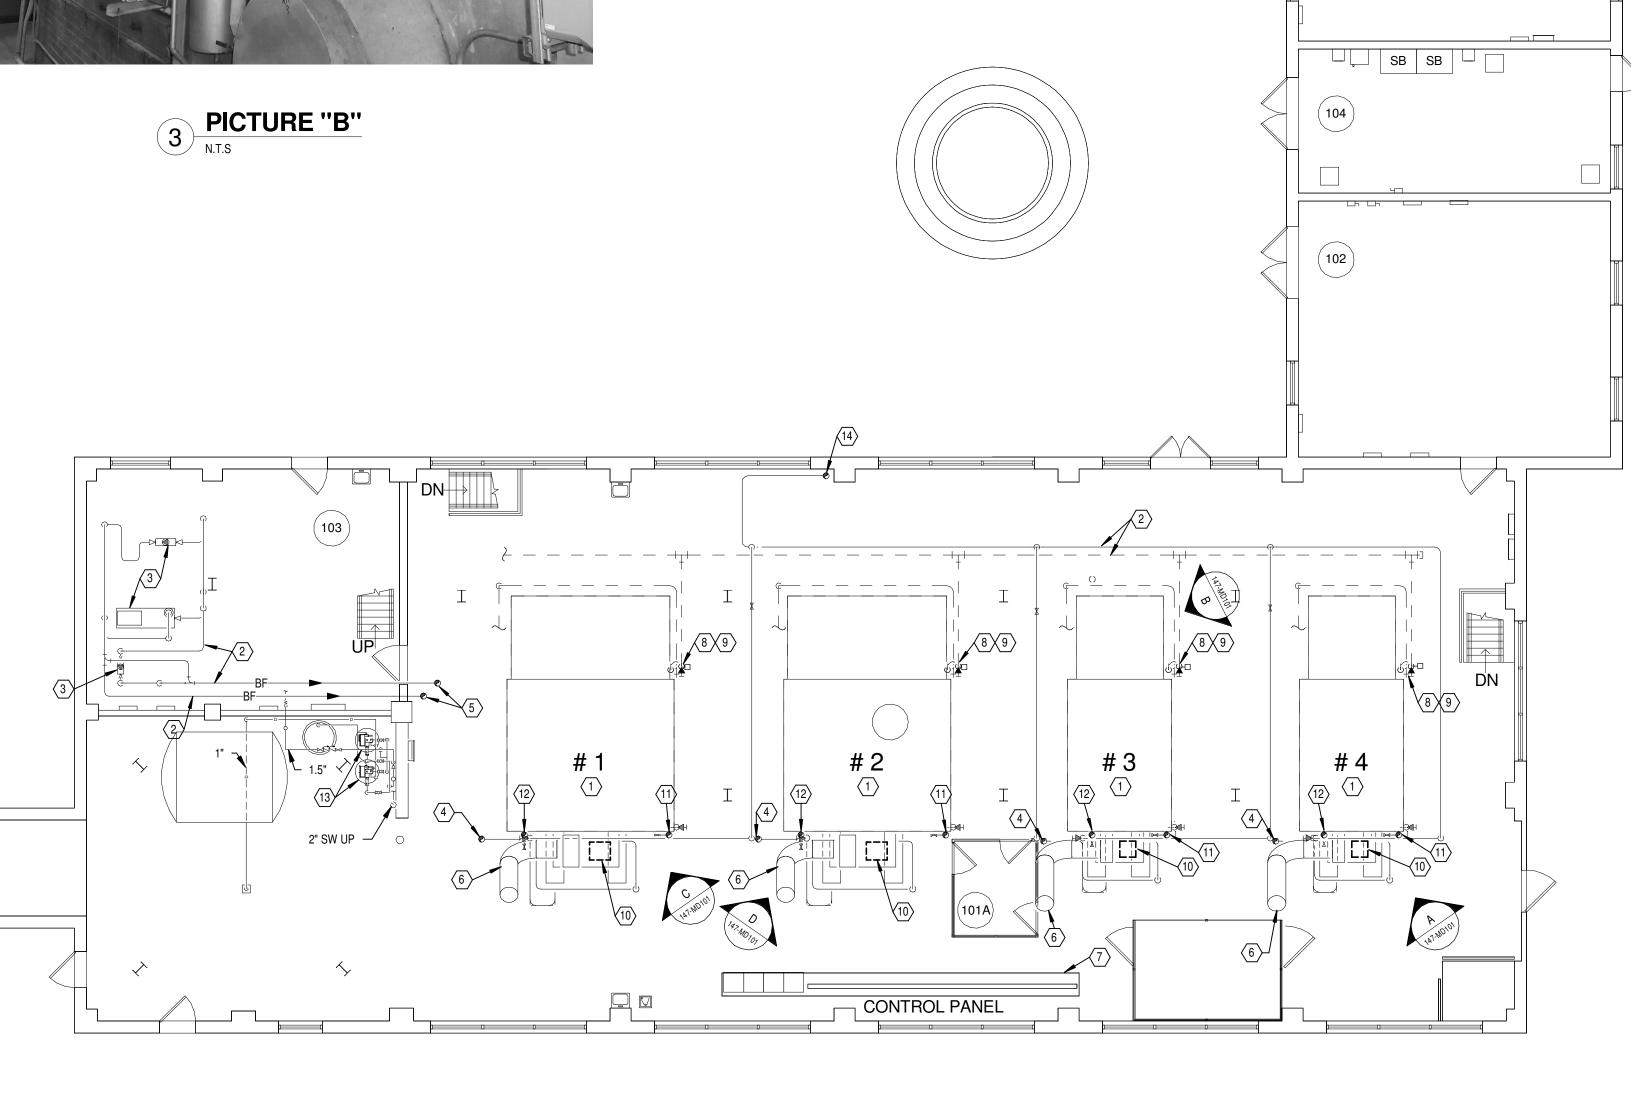

FIRST FLOOR PLAN

SCALE: 1/8" = 1'-0"

100% SUBMITTAL

GENERAL NOTES

○ PLAN NOTES

EXISTING BOILER TO REMAIN.

2 EXISTING PIPING TO REMAIN.

3 EXISTING PUMP TO REMAIN.

4 NATURAL GAS SUPPLY PIPING FROM ABOVE.

5 BOILER FEEDWATER PIPING UP TO SECOND FLOOR.

6 COMBUSTION AIR INTAKE DUCTWORK FROM ABOVE.

WITH DVAMC BOILER CONTROL TECHNICIAN.

9 REMOVE EXISTING CONDUCTIVITY PROBE.

11 FUEL OIL SUPPLY PIPING FROM ABOVE.

12 PROPANE SUPPLY PIPING FROM ABOVE.

13 EXISTING DUPLEX WATER SOFTENER.

14 HIGH PRESSURE STEAM (100) PIPING FROM ABOVE.

A REFER TO 147-M001 FOR LEGEND, ABBREVIATIONS, AND ADDITIONAL GENERAL NOTES.


B COORDINATE ALL BOILER SHUTDOWNS CLOSELY WITH THE C.O.R. FD AND ID FAN MOTOR REPLACEMENTS SHALL BE COMPLETED ONE AT A TIME WITH THE LARGE BOILER FAN MOTORS (BOILERS 1 & 2) REPLACED BETWEEN MAY 1 AND SEPTEMBER 1.

7 EXISTING BOILER MASTER AND SUBMASTER CONTROL SYSTEMS TO REMAIN. INTEGRATE NEW FD FAN VOLUME AND ID FAN VOLUME CONTROL FUNCTIONS INTO EXISTING SYSTEM. COORDINATE REQUIREMENTS WITH C.O.R. COORDINATE ALL CONTROL WORK CLOSELY

8 REMOVE EXISTING ELECTRIC BLOWDOWN VALVE, CONDUCTIVITY PROBE, AND ASSOCIATED WIRING, CONTROLS, ETC. FOR REPLACEMENT IN NEW WORK

10 REMOVE EXISTING BURNER FORCED DRAFT FAN MOTOR. REFER TO PICTURES ON THIS SHEET FOR MORE DETAILED INFORMATION.

C PICTURES SHOWN ARE TYPICAL OF EACH SIZE OF BOILER (2 SIZES IN PLANT).

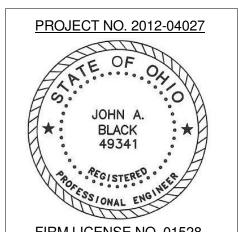



Ph: 937-224-0861 Fax: 937-224-5777 www.heapy.com

FIRST FLOOR - REMOVALS

Drawing Title

Approved: CHIEF ENGINEER

Project Title Modernize Boiler Plant B-147 Dayton, Ohio

DLE

Drawn PCW

Project No.

VA Project No. 552-13-305

Heapy Project No. 2012-04027 Building Number 147 Drawing Number

Office of Construction and Facilities Management 147-MD101 Department of Veterans Affairs

one-eighth inch = one foot